


UPVC PIPE
BEDDING CLASS 'E'

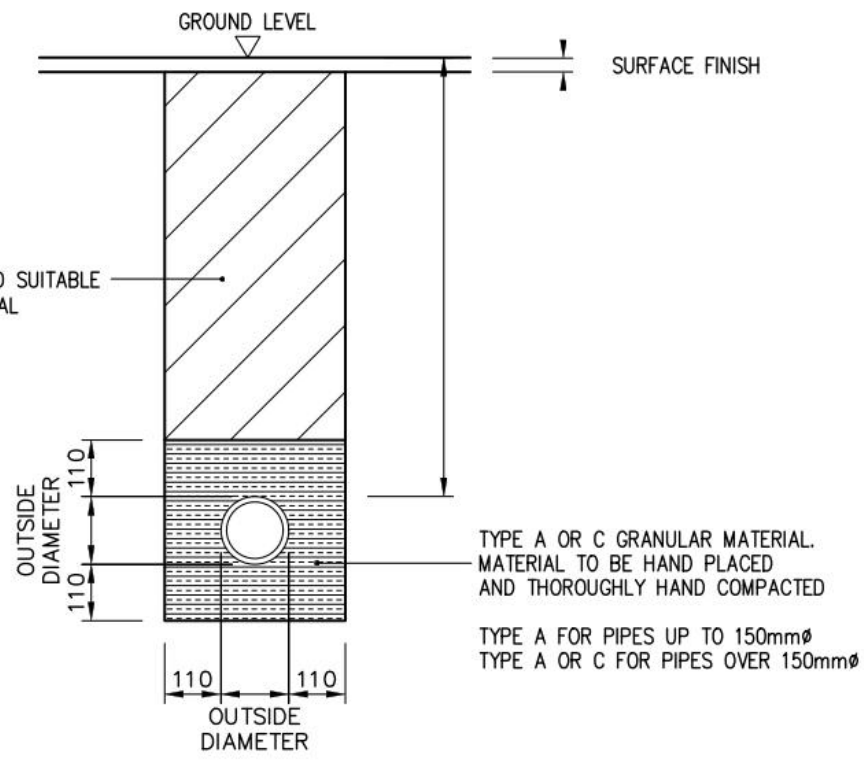

SCALE 1:20


- All works to be carried out in accordance with the following:-
1. UK water industry research Ltd. 'Civil Engineering Specification for the water Industry, 5th Edition.
 2. Building Regulations Section 'H'
 3. BE EN 752 Drain and Sewers Systems outside buildings.

- Foul Water: Falls in runs - 1:10 max - 1:60 min.
- All new drainage branches to be swept in direction of flow.
- All new drainage branches to be fitted with a RE.

SUDS

- All parking areas are to constructed with a porous build up on free draining stone.
- All pods to have a 250mm wide by a min 200mm deep gravel border to both draining sides.


Key for trees, tree canopy spreads and removals.

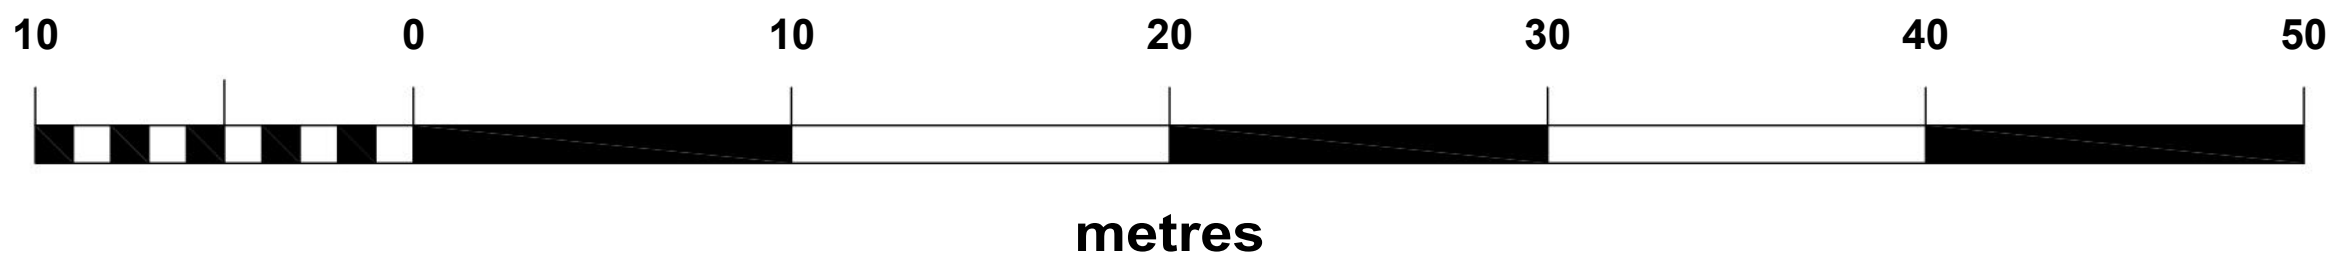

GLAMPitect

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KEY TO SYMBOLS

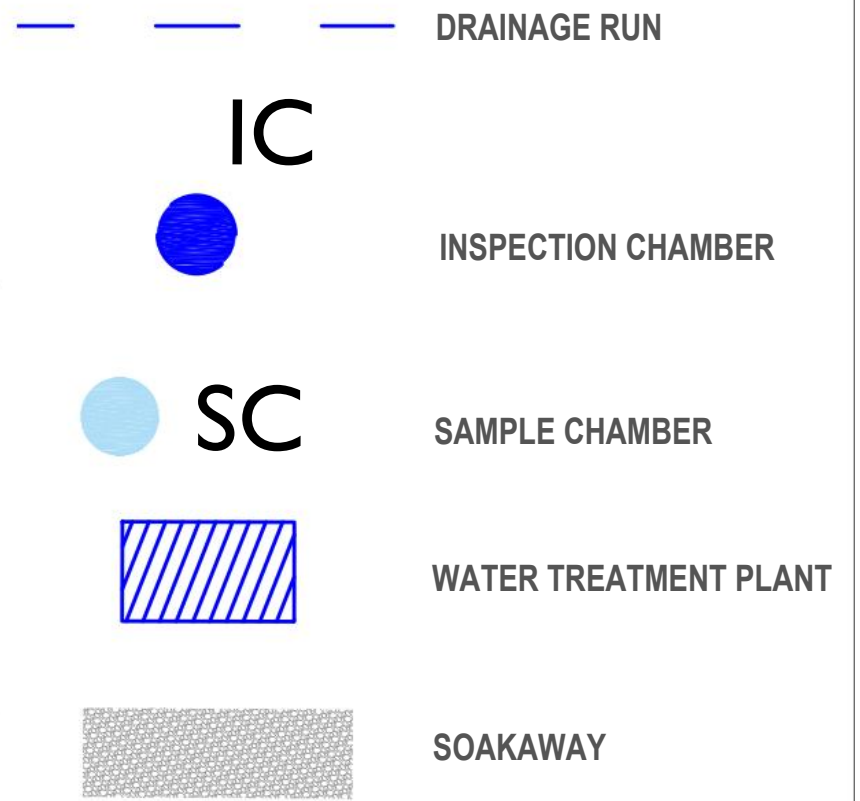

OWNERSHIP BOUNDARY
AREA = 5,813,644 m2

SITE BOUNDARY
SITE AREA = 8,476m2

Date	Description	Rev	By
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Revision Description



Project:
Proposed Glamping Site - For Stephen Thompson
Crump Hillocks Farm, Four Ashes, Nr Stourbridge
DY7 5JG

Drawing Title:
PROPOSED DRAINAGE PLAN

Drawing Number:
210534-01-04

Revision:
Date: 13.10.2022
Scale: 1:100 @ A1
Drawn By: EF
CAD Dwg File: -
Checked By: EC

Issue Status:
Full Planning Application